SECTION 00 90 01 BIDDING AND CONTRACT REQUIREMENTS ADDENDUM NUMBER (1)

Demonica Kemper Associates 100 Harrison Street Peoria, IL 61602 309.282.0170

To: Prospective Bidders

Issued: April 16th, 2024

Re: ADDENDUM NUMBER (1) TO THE BIDDING DOCUMENTS FOR

Peoria Park District

Golf Entertainment Facility Renovation an Addition

Architect's Project Number: 22-051

This addendum forms a part of the bidding and contract documents and modifies the original bidding documents dated April 9, 2024. Acknowledge receipt of this addendum in the space provided on Bid Form. FAILURE TO DO SO MAY SUBJECT BIDDER TO DISQUALIFICATION.

ADDENDA TO THE PROJECT MANUAL

A. N/A

ADDENDA TO THE DRAWINGS

CIVIL

A. The complete civil sheet list has been included in the sheet index. All sheets found within the bidding and permit set are to be included in the contractor bid.

ELECTRICAL - SEE REVISED SHEETS BELOW

- 1. Drawing E1.23 SECOND FLOOR PLAN RANGE BAYS SYSTEMS
 - a. Revised keyed note #1 for clarification of scope for fiber conduit installation from main building to range bays.
- 2. Drawing E4.1 TELECOMM. RISER, SCHEDULE, AND NOTES
 - a. Revised data equipment schedule to clarify scope of work and division of labor for electrical contractor and owners I.T. AND A/V representative.
 - b. Added boxed note for approved equivalents for electrical contractor furnished system components.

CLARIFICATIONS – ALL ANSWERS TO CONTRACTOR QUESTIONS BELOW IN RED

Top Tracer System – are we including that cost in our bid or is that going to be bid direct to the owner? E4.1 notes that it's a turnkey system by Top Tracer, so I wanted to see if we needed to reach out to them and if so, does anyone have a contact? E5.0 also notes it that sounds like it is direct by the owner, but E1.30 Note 1 says to "install".

Peoria Park District
Golf Entertainment Facility Renovation &
Addition
DKA Project No.: 22-051

ADDENDUM NO. 1 Section 00 90 01 The Top Tracer system components and programming will be installed/performed by a Top Tracer installer (<u>Top Tracer system to be purchased and installed by the Peoria Park District</u>). Any conduit required for cabling and conductors for the equipment is to be furnished and installed by the E.C. The lighting on top of the building as noted on E1.30 is NOT part of that system and must be furnished and installed by the E.C. and coordinated with the Top Tracer installers.

E4.2 notes the exit/em light allowance that's typical on all KED drawings. The callout types do not match what is on the fixture schedule, though.

This is a typo, they are to provide an allowance for additional emergency fixture type 'EM' at locations identified and required by local inspectors.

E4.0 Fire Alarm System General Notes – Note 3 says cable can be routed open above accessible ceiling but Note 5 says open cable not permitted. I don't know if they mean Note 5 for exposed or unfinished areas, but I wanted to clarify.

Cabling routed above accessible ceilings can be routed open. Cabling routed through areas of exposed or unfinished ceilings shall be in conduit. Open cabling is not permitted in exposed or unfinished spaces.

E4.1 Equipment Schedule Item 3 notes "OSF Standards". I know it will get brought up by the data people since this isn't an OSF job, so I wanted to bring it up now so there's no confusion about special standards they have to meet.

That was a missed copy/paste typo. I can fix in addendum.

E4.1 Sheet Keyed Note 1 says Fiber Termination Shelf is by owner, but the Equipment Schedule reads as its by the data contractor (us or our sub) and that the owner will be terminating and testing the cabling only.


The schedule should read owner FTS to furnish as well. Keyed note is correct. Owner furnishing all rack equipment, terminating at rack, and testing connections/network.

This addendum consists of (2) pages, excluding attachments.

END 009001.

Attachments:

- 1. G1.00 SHEET INDEX ABBREVATIONS, SYMBOLS AND GENERAL NOTES
- 2. E1.23 SECOND FLOOR PLAN RANGE BAYS SYSTEMS
- 3. E4.1 TELECOM, RISER, SCHEDULE AND NOTES

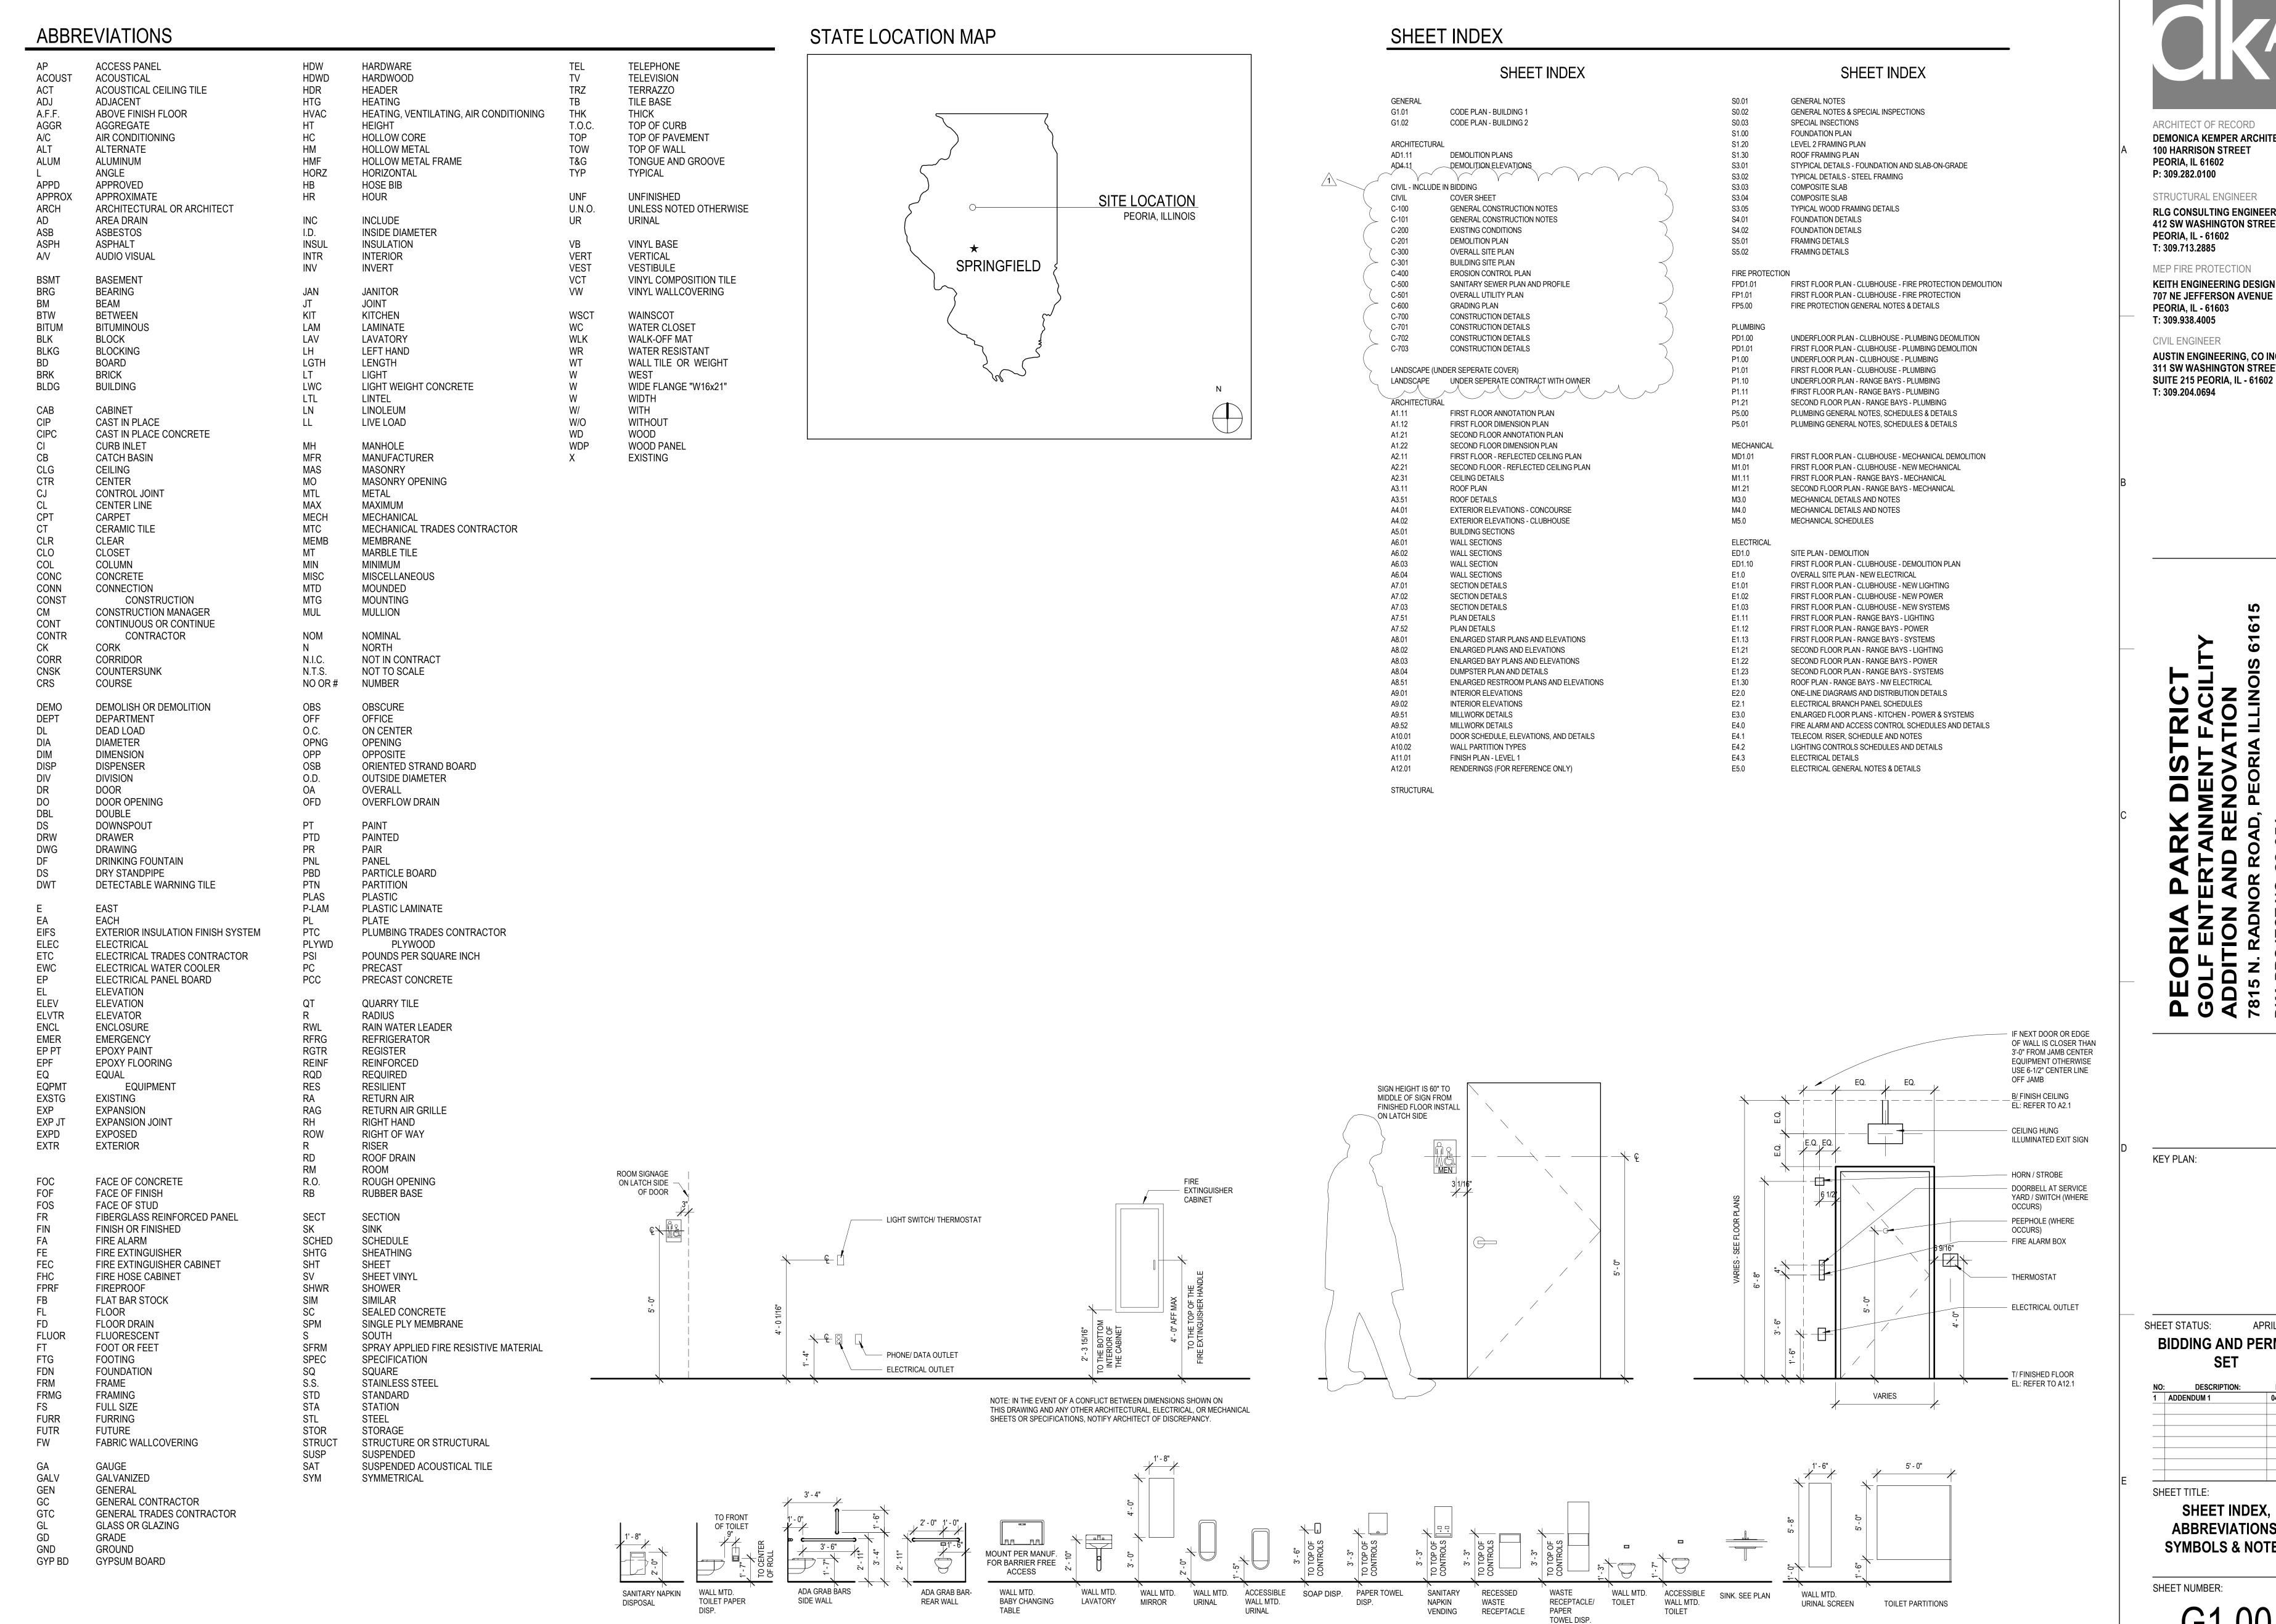



ARCHITECT OF RECORD DEMONICA KEMPER ARCHITECTS **100 HARRISON STREET**

PEORIA, IL 61602

P: 309.282.0100 STRUCTURAL ENGINEER


RLG CONSULTING ENGINEERS **412 SW WASHINGTON STREET** PEORIA, IL - 61602

T: 309.713.2885 MEP FIRE PROTECTION

KEITH ENGINEERING DESIGN 707 NE JEFFERSON AVENUE PEORIA, IL - 61603 T: 309.938.4005

CIVIL ENGINEER **AUSTIN ENGINEERING, CO INC.** 311 SW WASHINGTON STREET,

APRIL 9, 2024 SHEET STATUS: **BIDDING AND PERMIT**

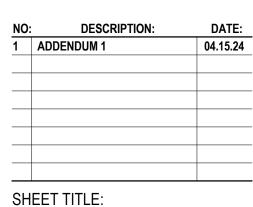

SHEET INDEX

ABBREVIATIONS, **SYMBOLS & NOTES**

SHEET NUMBER:

COMBO

4/15/2024 4:17:54 PM



ADDENDUM #: 01

DATE ISSUED: April 16, 2024

ADDENDUM

Attention: Arron Elmore

Demonica Kemper Architects

100 Harrison St. Peoria, IL 61602 Subject: Addendum #1

To The Bid Documents For: PPD - Golf Learning Center

7815 Radnor Rd. Peoria, IL 61615

Drawings

1. Drawing E1.23 - SECOND FLOOR PLAN - RANGE BAYS - SYSTEMS

- Revised keyed note #1 for clarification of scope for fiber conduit installation from main building to range bays.
- 2. Drawing E4.1 TELECOMM. RISER, SCHEDULE, AND NOTES
 - a. Revised data equipment schedule to clarify scope of work and division of labor for electrical contractor and owners I.T. AND A/V representative.
 - b. Added boxed note for approved equivalents for electrical contractor furnished system components.

Attachments

E1.23, E4.1

Signature

Alan Mowry

<u>Electrical Designer</u>

Printed Name & Title

707 NE Jefferson Ave : Peoria, IL 61603 : (309) 938-4005 : www.kedmep.com



ARCHITECT OF RECORD DEMONICA KEMPER ARCHITECTS **100 HARRISON STREET PEORIA, IL 61602** P: 309.282.0100

STRUCTURAL ENGINEER RLG CONSULTING ENGINEERS **412 SW WASHINGTON STREET** PEORIA, IL - 61602 T: 309.713.2885

MEP FIRE PROTECTION **KEITH ENGINEERING DESIGN 707 NE JEFFERSON AVENUE PEORIA, IL - 61603** T: 309.938.4005

CIVIL ENGINEER **AUSTIN ENGINEERING, CO INC.** 311 SW WASHINGTON STREET, **SUITE 215 PEORIA, IL - 61602** T: 309.204.0694


SHEET STATUS: APRIL 9, 2024 **BIDDING AND PERMIT** SET

NO	: DESCRIPTION:	DATE:		
1	ADD #1	04/16/24		

SHEET TITLE: SECOND FLOOR PLAN - RANGE BAYS -

SYSTEMS

4/16/2024 8:16:15 AM

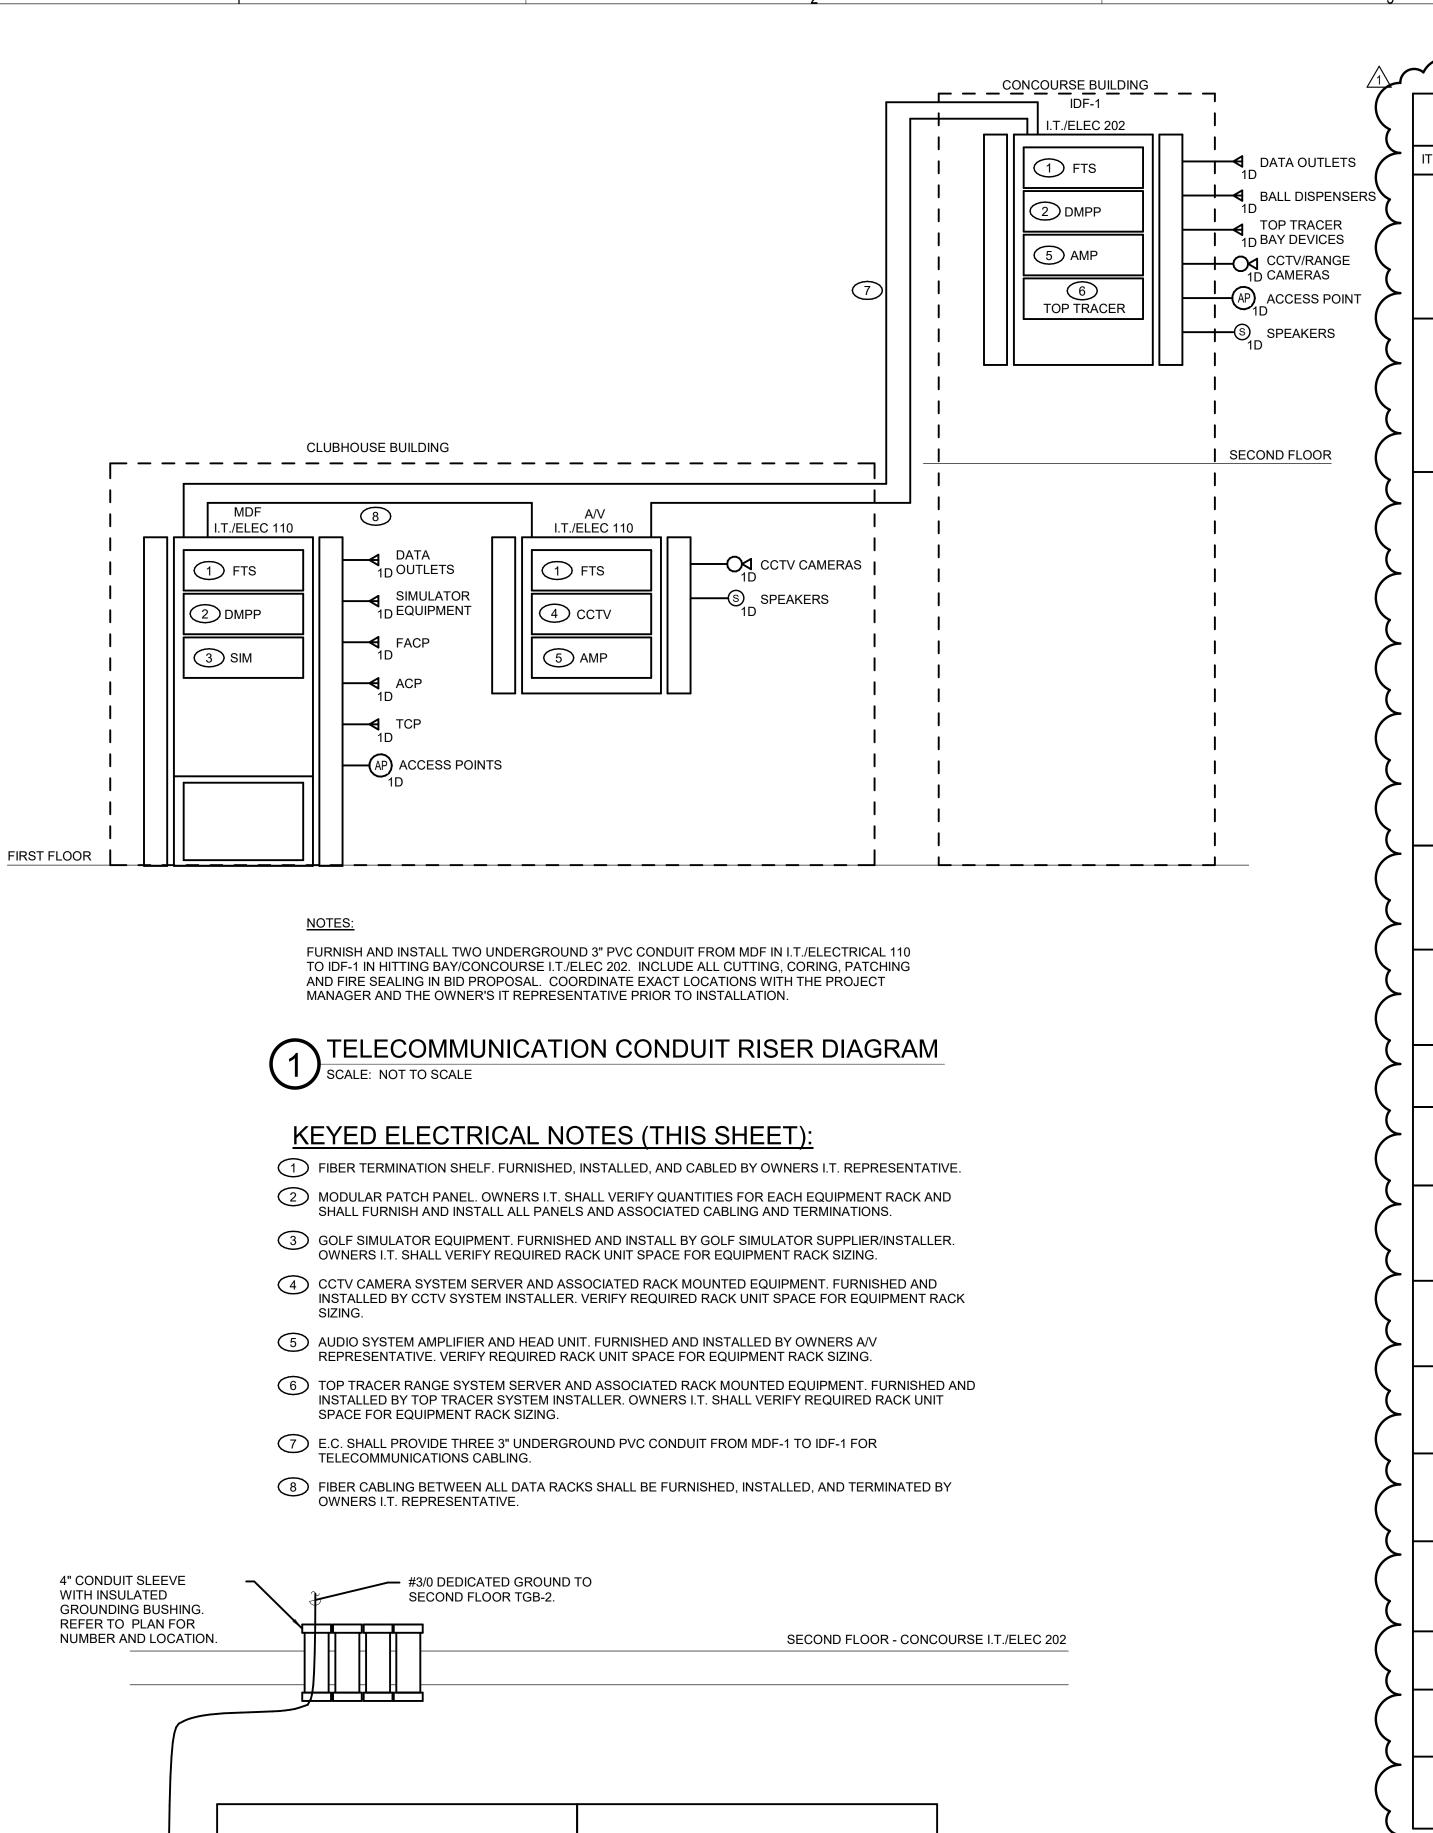

4' x 8' BACKBOARD ALL WALLS

RATED AND PAINTED WITH FIRE

FIRST FLOOR - CLUBHOUSE I.T./ELECTRICAL 110

NOTED ON PLANS. FIRE

RESISTANT WHITE PAINT.

#3/0 GROUND FROM MDP SERVICE GROUND

TELECOM TYPICAL TTB ELEVATION

SCALE: NOT TO SCALE

4' x 8' BACKBOARD ALL WALLS

RATED AND PAINTED WITH FIRE

NOTED ON PLANS. FIRE

RESISTANT WHITE PAINT.

4" CONDUIT SLEEVES

GROUNDING BUSHINGS. REFER TO PLAN FOR

NUMBER AND LOCATION.

WITH INSULATED

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ЕМ	SYMBOL	DESCRIPTION	MANUFACTURER
1	MDF DATA RACK AND ACCESSORIES	MAIN TELECOMMUNICATIONS RACK, FOUR-POST, SHALL HAVE MINIMUM 45RU. FURNISHED BY OWNER, INSTALLED BY OWNERS I.T. REPRESENTATIVE. E.C. SHALL BE RESPONSIBLE FOR ALL ROUGH-IN OF CONDUIT AND BACK BOXES BETWEEN DATA RACKS AND EQUIPMENT. COORDINATE ALL WORK WITH THE OWNER'S IT REPRESENTATIVE PRIOR TO INSTALLATION.	FURNISHING AND INSTALLATION OF EQUIPMENT AND TERMINATIONS SHALL BE DONE BY THE OWNERS I.T. REPRESENTATIVE.
			E.C. SHALL BE RESPONSIBLE FOR ALL ROUGH-IN CONDUIT, BACK BOXES, AND CABLING.
2	IDF-1, A/V DATA RACK AND ACCESSORIES	WALL MOUNTED DATA RACK, SHALL HAVE A MINIMUM OF 24 RU FOR EQUIPMENT. FURNISHED BY OWNER, INSTALLED BY OWNERS I.T. REPRESENTATIVE. E.C. SHALL BE RESPONSIBLE FOR ALL ROUGH-IN OF CONDUIT AND BACK BOXES BETWEEN DATA RACKS AND EQUIPMENT. E.C. SHALL BE REPONSIBLE FOR PULLING ALL A/V ASSOCIATED CABLING TO EQUIPMENT RACKS FOR TERMINATION	FURNISHING AND INSTALLATION OF EQUIPMENT, CABLING, AND TERMINATIONS SHALL BE DONE BY THE OWNERS I.T. REPRESENTATIVE.
		BY OWNERS I.T./A.V. REPRESENTATIVE. COORDINATE ALL WORK WITH THE OWNER'S IT REPRESENTATIVE PRIOR TO INSTALLATION.	E.C. SHALL BE RESPONSIBLE FOR ALL ROUGH-IN CONDUIT AND BACK BOXES AND A/V CABLING
3	NEW TELE-DATA OUTLET	NEW TELECOMMUNICATION VOICE/ DATA OUTLET. ROUGHED-IN AND CABLED BY THE ELECTRICAL CONTRACTOR, TERMINATED BY A CERTIFIED IT INSTALLER. THE INSTALLER'S PROPOSAL SHALL BE INCLUDED AS PART OF THE ELECTRICAL CONTRACTOR'S BID PROPOSAL. COVERPLATE SHALL CONSIST OF A MODULAR FOUR PORT CONFIGURATION. ALL UNUSED PORTS SHALL HAVE REMOVABLE BLANKS INSERTED FOR FUTURE USE. '#D' SUBSCRIPT NEXT TO SYMBOL INDICATES THE QUANTITY OF DATA OUTLETS TO BE PROVIDED IN THE OPENING. EACH JACK SHALL BE A RJ-45 CATEGORY 6 OUTLET.	SYSTIMAX ELECTRICAL CONTRACTOR TO PROVIDE ALL ROUGH-IN AND CABLING LABOR AND MATERIALS. OWNERS A/V REPRESENTATIVE SHALL PROVIDE ALL DATA MEDIA SYSTEM COMPONENT MATERIALS AND LABOR AND SHALL BE INCLUDED IN THE ELECTRICAL BID PROPOSAL.
		ALL DATA CABLING SHALL BE BLUE CATEGORY 6 PLENUM RATED FOUR PAIR UTP. ALL CABLES SHALL BE TERMINATED TO A NEW PATCH PANEL IN THE UPPER RIGHT RACK IN MDF-1. CABLING MAY BE ROUTED OPEN ABOVE ACCESSIBLE CEILINGS. ALL OPEN CABLING SHALL BE PER OSF STANDARDS. ALL EXPOSED CABLING SHALL BE ROUTED IN CONDUIT IN UNFINISHED AREAS. SURFACE MOUNTED INSTALLATIONS IN FINISHED SPACES ARE NOT PERMITTED. "W" SUBSCRIPT INDICATES A WALL PHONE OUTLET. VERIFY THE EXACT MOUNTING HEIGHT PRIOR TO ROUGH-IN.	COVER PLATE SYSTIMAX BLANKS SYSTIMAX CONNECTORS SYSTIMAX CABLE SYSTIMAX J-HOOKS PANDUIT JP2W-L20 PANDUIT JP4W-X20
4	(AD)	TELECOMMUNICATIONS WIRELESS ACCESS POINT FURNISHED AND INSTALLED BY OWNERS I.T. REPRESENTATIVE. E.C. SHALL BE RESPONSIBLE FOR ALL ROUGH-IN OF CONDUIT AND BACK BOXES.	HOOK AND LOOP TAPE PANDUIT TTS-20RO INSTALLED, TERMINATED AND TESTED BY THE OWNERS I.T.
	AP _{1D}	E.G. GIWLE BE REGI GROBEL I GROBEL IN GI GORDON 7448 BINGRESS.	REPRESENTATIVE.
5	FTS	FIBER TERMINATION SHELF, RACK MOUNTED FIBER DISTRIBUTION ENCLOSURE, FIBER ADAPTER PANELS, AND TYPE LC FIBER CONNECTORS. OWNERS IT REPRESENTATIVE SHALL TERMINATE AND TEST ALL FIBER OPTIC CABLING AS INDICATED ON THE DRAWINGS AND SPECIFICATIONS. SYSTIMAX FIBER TRAY FIBER ADAPTER MO FIBER CONNECTORS	
6	DMPP	MODULAR PATCH PANEL FURNISHED AS PART OF MDF. SEE PLANS AND SPECIFICATIONS FOR DESCRIPTION. PROVIDE QUANTITY AS REQUIRED BY THE NUMBER OF CABLES AND SPARE CAPACITY REQUIRED BY THE DRAWINGS AND SPECIFICATIONS.	SYSTIMAX FLAT PLATE PATCH PANEL
7	TGB-1	MAIN TELECOMMUNICATIONS GROUND BAR. HIGH CONDUCTIVITY COPPER AND TIN-PLATED TO INHIBIT CORROSION. 1/4" X 2" X 12" PRE-ASSEMBLED WITH BRACKETS AND INSULATORS ATTACHED. SEE DRAWINGS FOR QUANTITIES, LOCATIONS AND ADDITIONAL WORK REQUIRED.	
8	TTB-1	TELEPHONE TERMINAL BOARD FURNISH AND INSTALL ONE 4' X 8' X 3/4" FIRE RATED PLYWOOD. PROVIDE TWO COATS OF FIRE RESISTANT WHITE PAINT. MOUNT VERTICALLY TO WALL SUCH THAT THE MIDDLE OF THE PLYWOOD IS 48" ABOVE FINISHED FLOOR.	
9	S _{S1}	COAXIAL CEILING SPEAKER, 8" DIAMETER, 60W, 70.7V/100V TRANSFORMER, 90dB SENSITIVITY, FRONT MOUNTED TAP SELECTOR. E.C. SHALL BE RESPONSIBLE FOR ALL ROUGH-IN OF CONDUIT AND BACK BOXES. VERIFY MOUNTING HEIGHTS WITH ARCHITECTURAL ELEVATIONS PRIOR TO ROUGH-IN.	ATLAS IED FAP82T FURNISHED BY OWNERS A/V REPRESENTATIVE
10	⑤ S2	COAXIAL CEILING SPEAKER, 8" DIAMETER, 16W, 70.7V/100V TRANSFORMER, 90dB SENSITIVITY, FRONT MOUNTED TAP SELECTOR. E.C. SHALL BE RESPONSIBLE FOR ALL ROUGH-IN OF CONDUIT AND BACK BOXES. VERIFY MOUNTING HEIGHTS WITH ARCHITECTURAL ELEVATIONS PRIOR TO ROUGH-IN.	ATLAS IED FAP42T FURNISHED BY OWNERS A/V REPRESENTATIVE
11	© _{S3}	DROP-IN 2'X2' CEILING SPEAKER, SUITABLE FOR USE IN GRID CEILINGS, ALUMINUM WOOFERS, 360 DEGREES HEMISPHERICAL SOUND, FIRE RETARDANT ABS MATERIAL, CAN BE PAINTED TO MATCH CEILING, 160W, 92dB SENSITIVITY, 70V TRANSFORMER. E.C. SHALL BE RESPONSIBLE FOR ALL ROUGH-IN OF CONDUIT AND BACK BOXES.	PURE RESONANCE SD4 FURNISHED BY OWNERS A/V REPRESENTATIVE
12	S _{S4}	8" 2-WAY ALL-WEATHER SPEAKER, INJECTION MOLDED, UV RESISTANT, POWDER COATED ALUMINUM GRILLS, BLACK HOUSING, 60W, 70V/100V TRANSFORMER, 92dB SENSITIVITY. E.C. SHALL BE RESPONSIBLE FOR ALL ROUGH-IN OF CONDUIT AND BACK BOXES.	ATLAS IED SM82T-B FURNISHED BY OWNERS A/V REPRESENTATIVE
13	Ø	OWNER PROVIDED CAMERA, G5 BULLET. E.C. SHALL BE RESPONSIBLE FOR ALL ROUGH-IN OF CONDUIT AND BACK BOXES.COORDINATE FINAL LOCATIONS WITH OWNERS A/V REPRESENTATIVE PRIOR TO ROUGH-IN. INSTALLED AND CABLED BY OWNERS A/V REPRESENTATIVE.	OWNER SUPPLIED AND INSTALLED G5 BULLET
14		OWNER PROVIDED CAMERA, G4 PTZ. E.C. SHALL BE RESPONSIBLE FOR ALL ROUGH-IN OF CONDUIT AND BACK BOXES.INSTALLED AND CABLED BY OWNERS A/V REPRESENTATIVE.	OWNER SUPPLIED AND INSTALLED G4 PTZ
15	TOP TRACER	TOP TRACER RACK MOUNTED SERVER FOR RANGE SYSTEM, 2RU. FURNISHED, INSTALLED, AND CABLED BY TOP TRACER SYSTEM INSTALLER.	TOP TRACER RACK EQUIPMENT FURNISHED AN INSTALLED BY TOP TRACER SYSTEM INSTALLER.

Straight-Through Ethernet Cable Pin Out for T568B

RJ45 Pin#	Wire Color (T568B)	Wire Diagran (T568B)	
1	White/Orange		
2	Orange		
3	White/Green		
4	Blue		
5	White/Blue		
6	Green		
7	White/Brown		
8	Brown		

Telephone Married Colors


T4 = WHITE with brown mark R4 = BROWN with white mark Telephone Jack RJ14 wire map

Eight-strand colors Four-strand equivalent Ti = WHITE with blue mark — R1 = BLUE with white mark — Green Red T2 = WHITE with orange mark — R2 = ORANGE with white mark T3 = WHITE with green mark R3 = GREEN with white mark

RJ14

RJ 45 CONNECTOR DETAIL
SCALE: NOT TO SCALE

SYSTIMAX USED FOR BASIS OF DESIGN OF NETWORK AND I.T. COMPONENTS AND CABLING. ALTERNATE
MANUFACTURERS MAY USED THAT CAN MEET OR EXCEED DESIGN STANDARDS OF THE SYSTIMAX SYSTEM. ACCEPTABLE ALTERNATES INCLUDE BUT NOT LIMITED TO: -COMMSCOPE

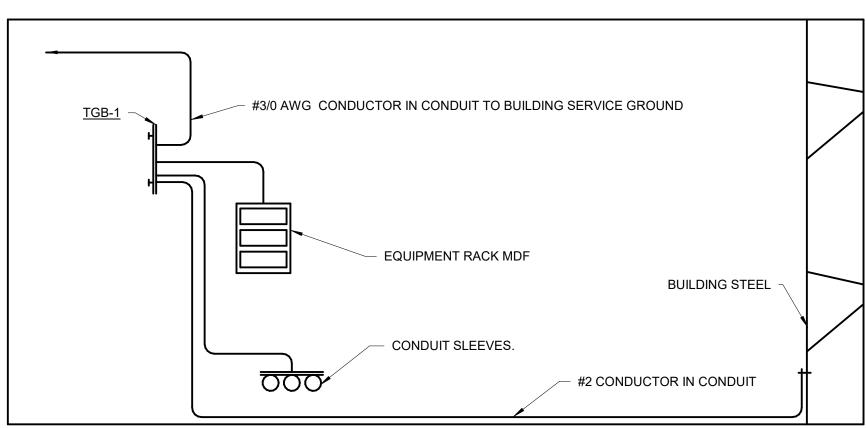


NOTES:

1. ALL CONDUCTORS IN THIS GROUNDING RISER SHALL BE #6 AWG COPPER CONDUCTORS (GREEN) UNLESS DISTANCE IS GREATER THAN 12 FEET.

2. GROUNDING DETAIL IS DIAGRAMMATIC, REFER TO ENLARGED PLANS FOR QUANTITIES AND LOCATION OF EQUIPMENT.

TELECOMMUNICATIONS ROOM GROUNDING DETAIL

SCALE: NOT TO SCALE

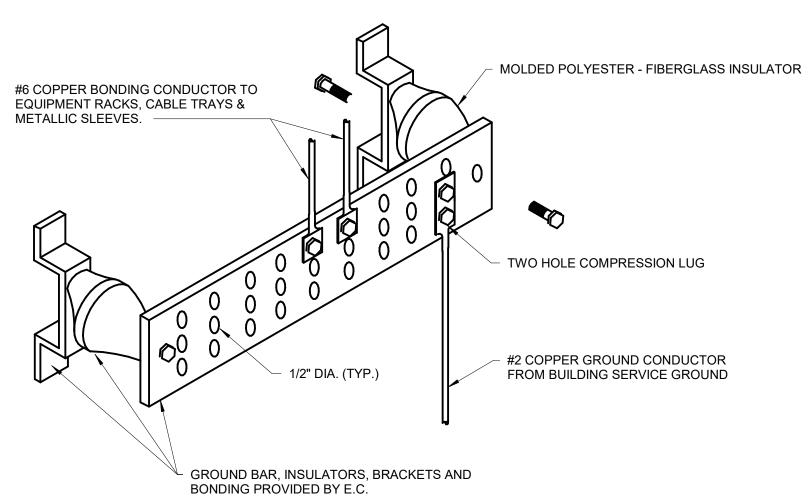

NOTES: 1. MOUNT BAR AT +24" A.F.F.

TGB-1 GROUND BAR DETAIL

SCALE: NOT TO SCALE

ARCHITECT OF RECORD DEMONICA KEMPER ARCHITECTS **100 HARRISON STREET PEORIA, IL 61602** P: 309.282.0100

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DATE: 4/9/2024

KEY PLAN:

SHEET STATUS: APRIL 9, 2024 **BIDDING AND PERMIT**

DESCRIPTION: SHEET TITLE:

TELECOMM. RISER, SCHEDULE, AND **NOTES**

SHEET NUMBER:

4/16/2024 8:16:16 AM